
Sheet Index

	Sheet Title	Sheet No.
	Conoral Site Man	
	General Site Map	SB-GSP
	Site Map of Monument Sign Location	SB-MSP
	Photos of Existing Site Identification	SB-M1.0
	Site Identification at Purpose Drive (Plan View)	SD-M1.1
	Site Identification at Purpose Drive (Section View)	SD-M1.2
	Site Map of Vehicular Signs	SB-VSP
	Primary Directional Sign	SB-V1.0
	Secondary Directional Sign	SB-V2.0
	Primary Informational Sign	SB-V3.0
	Secondary Informational Sign	SB-V4.0
	Parking Lot Identification Sign	SB-V5.0
	Vehicular Regulatory Sign	SB-V6.0
	Site Map of Pedestrian Signs	SB-PSP
	Primary Pedestrian Kiosk	SB-P1.0
	Secondary Pedestrian Kiosk	SB-P2.0
	Primary Pedestrian Directional Sign	SB-P3.0
	Secondary Pedestrian Directional Sign	SB-P4.0
	Site Map of Promotional Signs	SB-PRSP
_	Proposed Promotional Bridge Mounted Sign	SB-PR1.0
	Photos of Existing Promotional Signs	SB-PR1.1
	Photos of Existing Building Identification	SB-B1.0
	Photos of Existing Building Identification	SB-B1.1

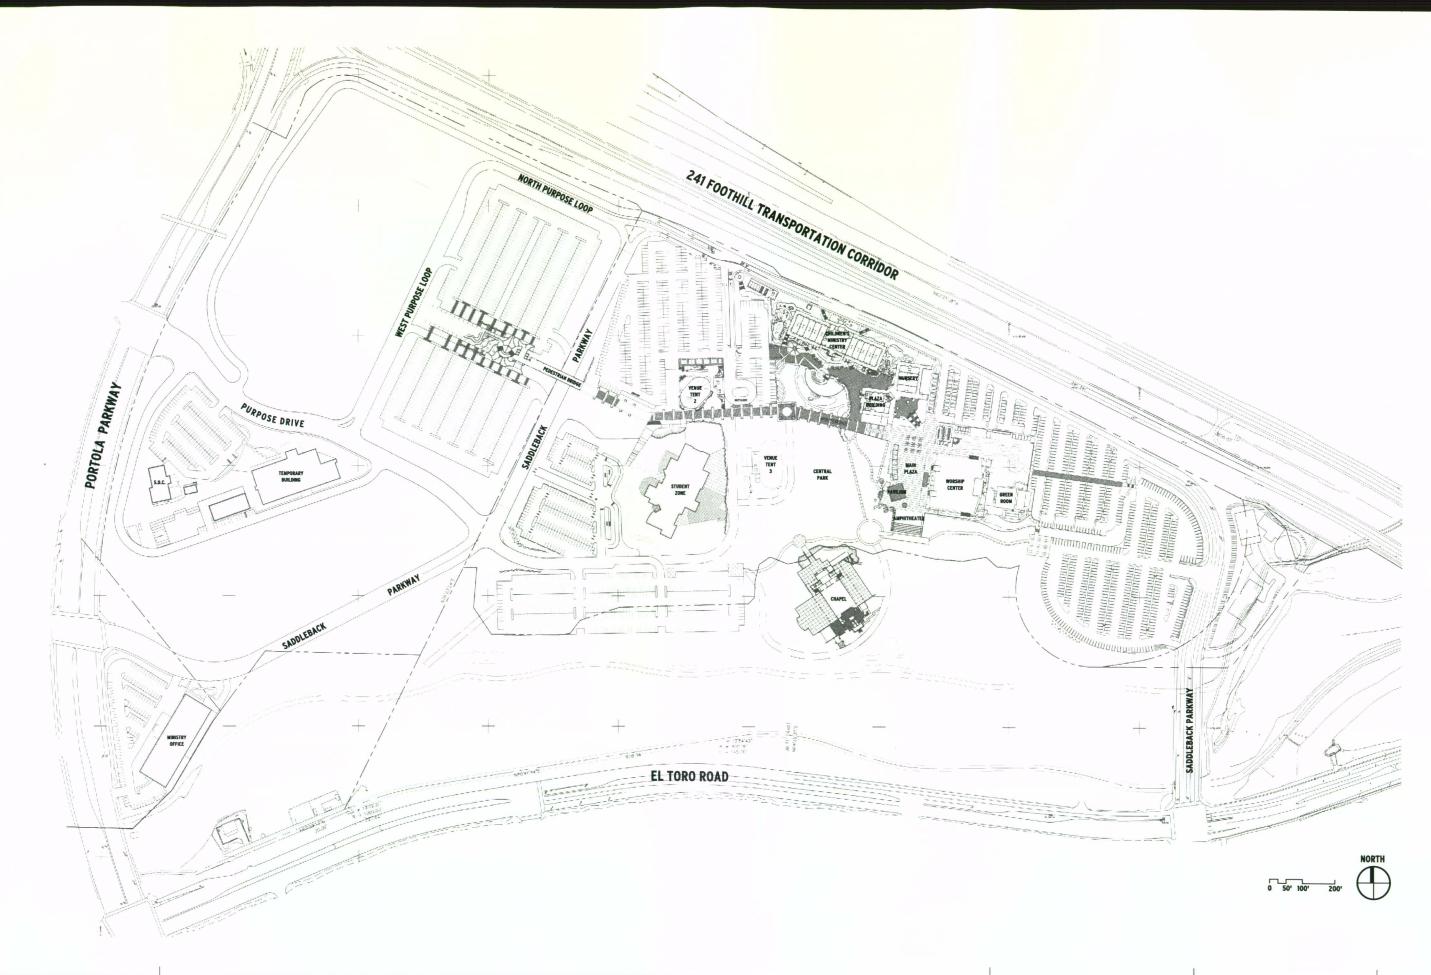



SADDLEBACK


Development Corporation

5 Rocky Road • Lake Forest, CA 92630 • (949 609-8260 • fax: (949)609-8282

Project Saddleback Church Campus Site: Planned Sign Program

Sheet Title
General Site Plan

Sheet Number
SB - GSP

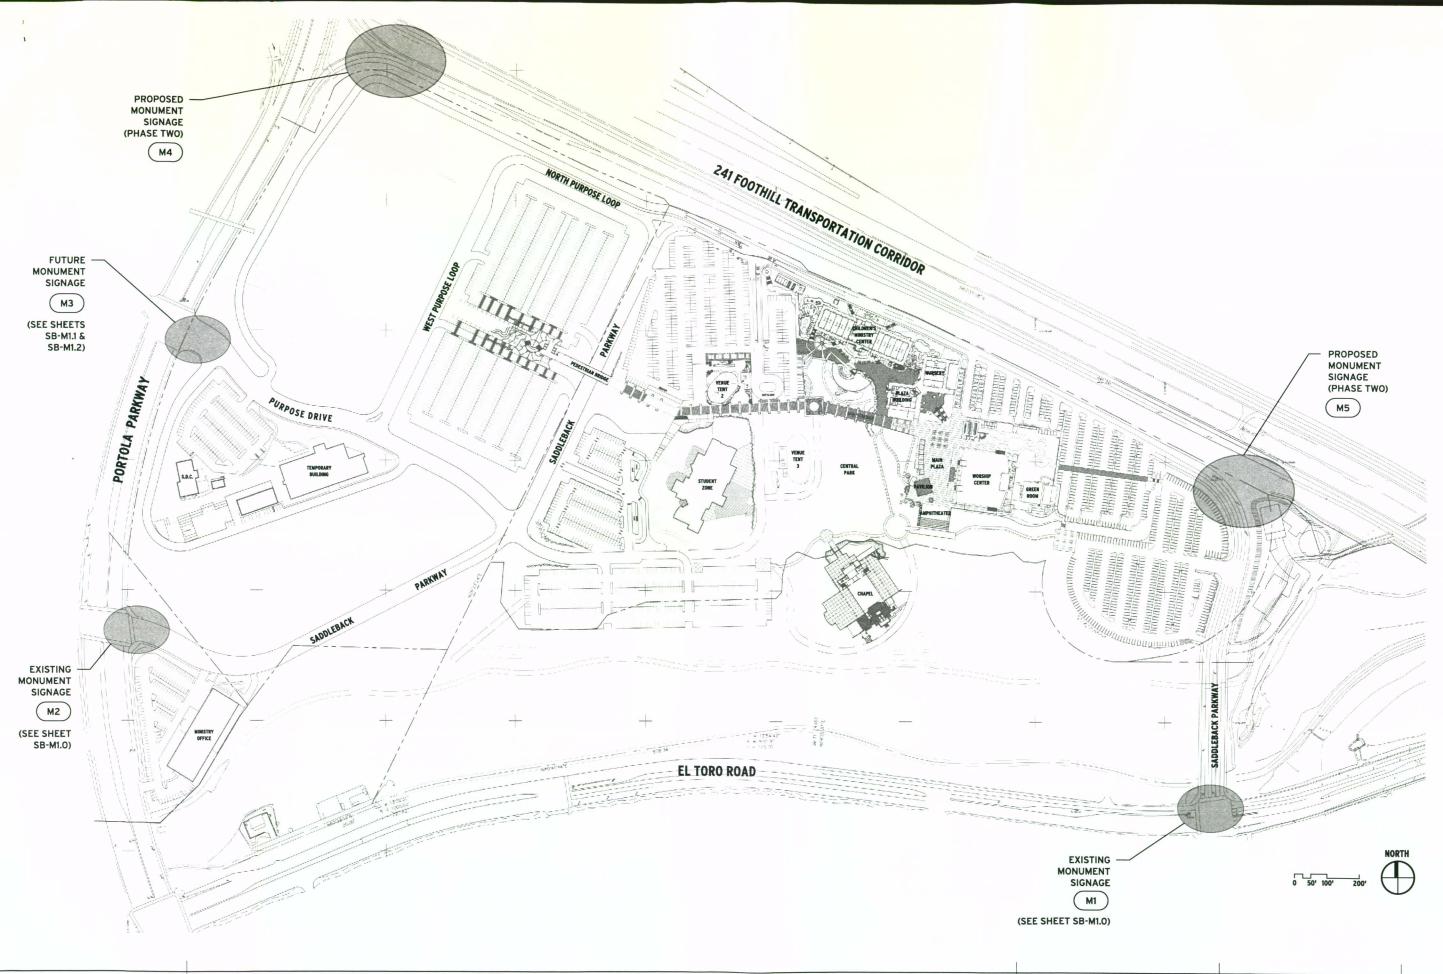





Project

Saddleback Church

Campus Site: Planned Sign Program

Monument Sign Location Plan Sheet Number
SB - MSP

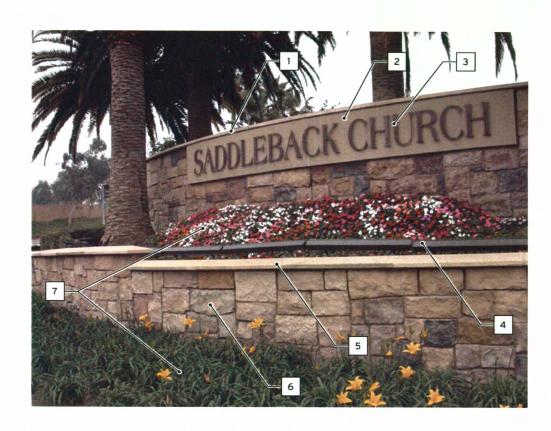

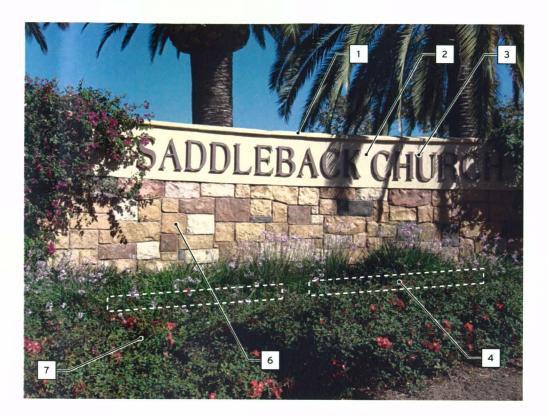

Existing Monument Photo - Portola Parkway Entrance

Scale: n.t.s.

Existing Monument Photo - El Toro Road Entrance

Scale: n.t.s.



Project
Saddleback Church

Signtype: M1 Photos of Existing Site Identification

Sheet Number SB - M1.0 Date 12-05-05

Existing Site Identification

7'-0" maximum height above grade.

1 Upper wall with concrete cap.

2 Precast concrete panels.

3 1'-6" pin mounted letters. Font: Amphion Bold

lighting fixtures.

above grade.

terrace.


4 Linear fluorescent ground mounted

5 Lower wall with concrete cap, steps with grade. 3'-0" maximum height

6 Earth tone simulated stone veneer.

7 Planted areas at foreground and first

Campus Site: Planned Sign Program

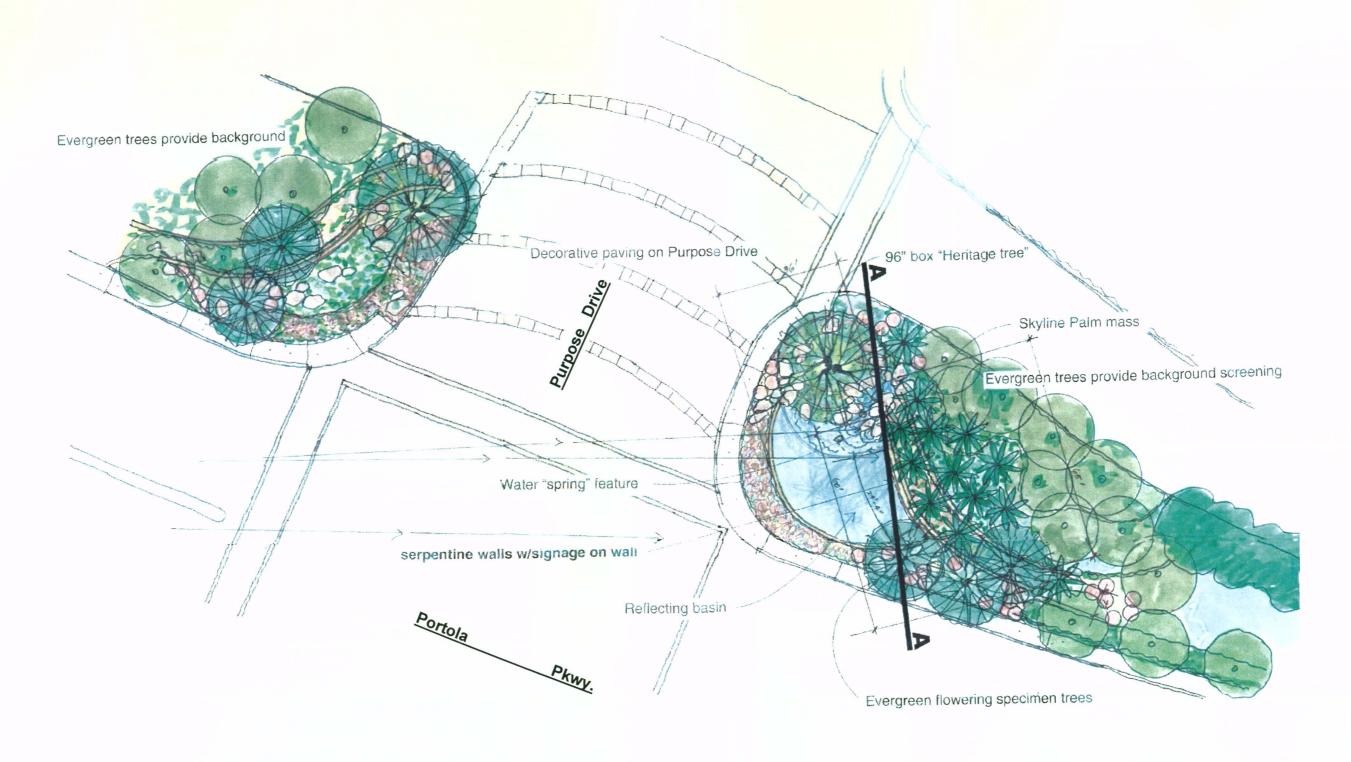

M3 Plan View - Site Identification at Purpose Drive

Scale: n.t.s.




Project Saddleback Church Campus Site: Planned Sign Program Sheet Title
Signtype: M3
Site Identification at Purpose Drive

SB - M1.1

Date 12-05-05

Site Identification at Purpose Drive

- 1 Precast concrete cap.
- 2 Simulated stone veneer wall with earth tone color mix.
- 3 Poured-in-place concrete pool.
- Boulder retaining wall and water fall, to be field located.
- 5 Bronze metal pin-mounted sign letters.
- 6 pool drain, see MEP plans.
- 7 Fluorescent underwater sign lighting.
- 8 Sidewalk, see civil plans.
- 9 Poured-in-place concrete footing.
- 10 Poured-in-place concrete wall.

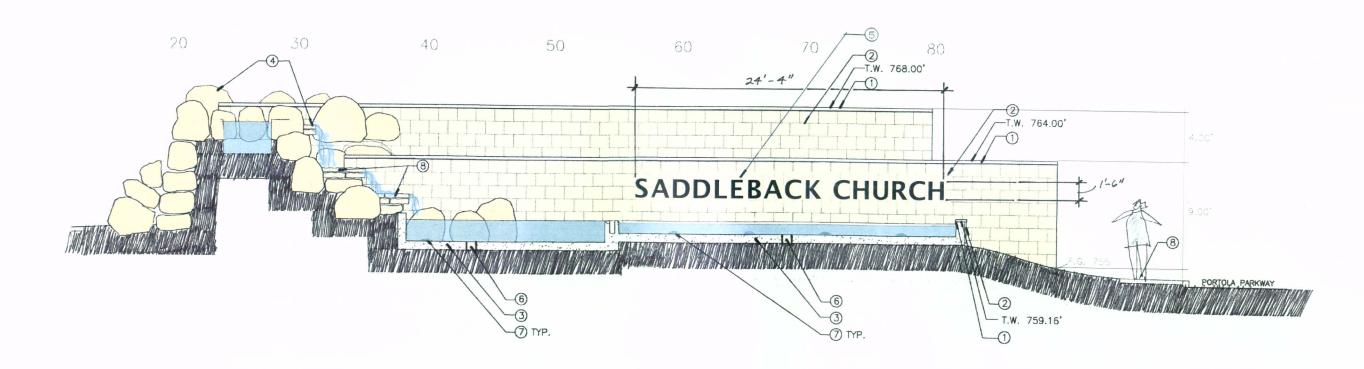

Section View - Site Identification at Purpose Drive

Scale: 1/8" = 1'-0"




Project Saddleback Church

Saddleback Church
Campus Site: Planned Sign Program
Site Identification at 1

Sheet Title
Signtype: M3
Site Identification at Purpose Drive

SB - M1.2

Date 12-05-05

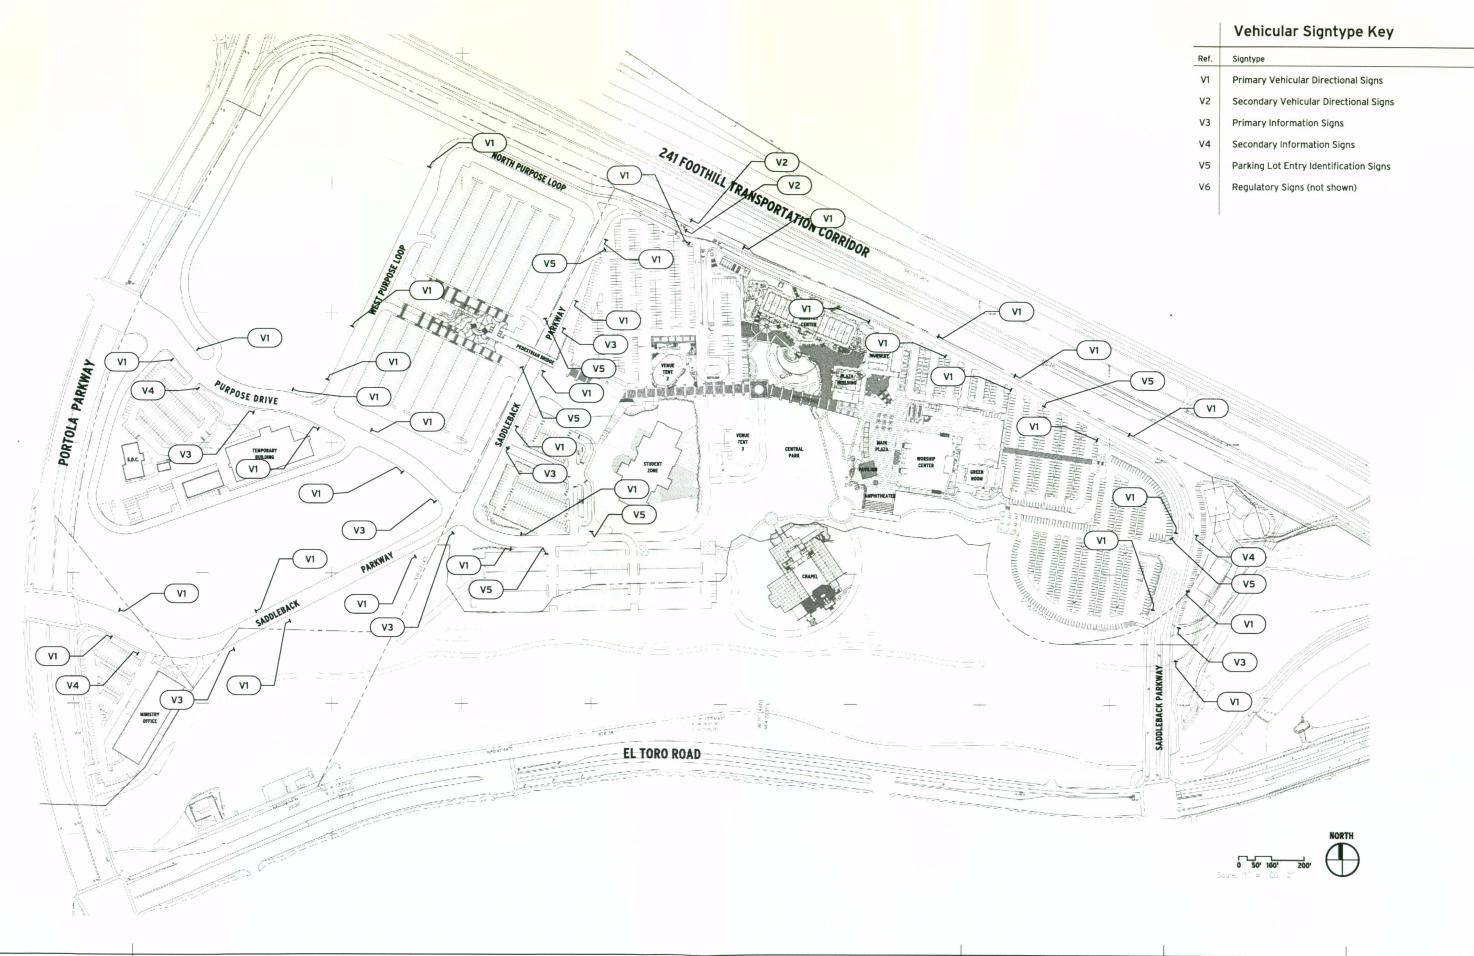




Project

Saddleback Church

Campus Site: Planned Sign Program

Sheet Title
Vehicular Wayfinding
Sign Location Plan

SB - VSP
Date
12-08-05

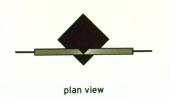



1 Elevations and Plan View

Scale: 1/2" = 1'-0"

V3 Primary Informational Sign

Post and panel sign with 3/16" thick painted aluminum face panel secured to 1" undersized, 1/8" thick painted aluminum sub-panel with VHB tape and silicone. Sub-panel to be mechanically secured to 11/2" x 2 1/2", 1/8" wall aluminum "U" channel mounting bracket. Mounting bracket to be welded to 4" square, 3/16" wall, painted aluminum tube support post . Fabricated painted aluminum accent bars to be mechanically secured to top/bottom of face panel. Copy to be applied die cut vinyl with protective satin clear coat. Post to have mechanically secured, painted cast aluminum cap and base cladding.

Colors

Сору


Post, Cap and Base Benjamin Moore Deep Bronze


Accent Bars Matthews Warm Metallic; MP20046

Face Panels Frazee Ocrah Rust; FZ8245A

Face Panel Strip Frazee Brick Shadow; FZ8326N

White Reflective Vinyl

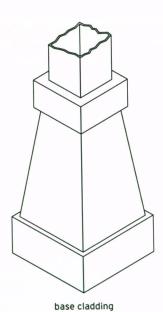

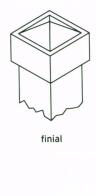

2 Isometric View - Base and Finial

Scale: 1" = 1'-0"

SADDLEBACK

Development Corporation


5 Rocky Road • Lake Forest, CA 92630 • (949 609-8260 • fax: (949)609-8282

Saddleback Church
Campus Site: Planned Sign Program

Sheet Title
Signtype: V3
Primary Informational Sign
Conceptual Design

SB - V3.0



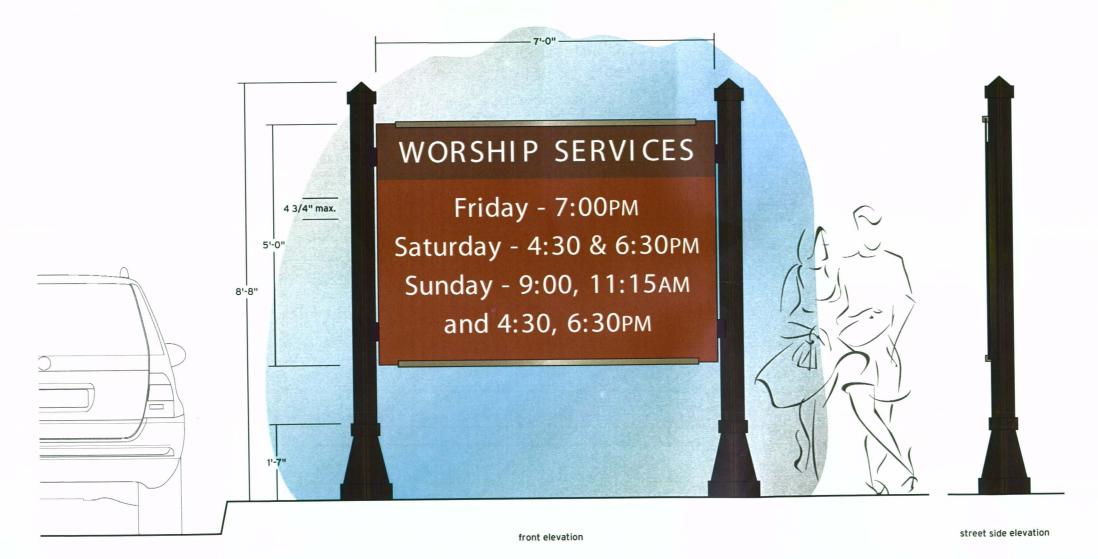

V4 Secondary Informational Sign

Post and panel sign. Face panel to be 3/16" thick painted aluminum with applied die cut vinyl with protective satin clear coat; mechanically secured to support posts with custom fabricated painted aluminum bracketing system. Fabricated painted aluminum accent bars to be mechanically secured to top/bottom of face panels. Support posts to be 4" square, 3/16" wall, painted aluminum tube. Each post to have mechanically secured, painted cast aluminum cap and base cladding.

Colors


Post, Cap and Base Benjamin Moore Deep Bronze

Accent Bars Matthews Warm Metallic; MP20046

Face Panel Frazee Ocrah Rust; FZ8245A

Face Panel Side Strip Frazee Brick Shadow; FZ8326N

Copy White Reflective Vinyl

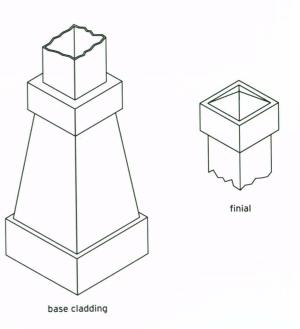

2 | Isometric View - Base and Finial

Scale: 1" = 1'-0"

1 Elevations and Plan View

Scale: 1/2" = 1'-0"



Saddleback Church
Campus Site: Planned Sign Program


Sheet Title
Signtype: V4
Secondary Informational Sign
Conceptual Design

SB - V4.0

12-08-05



plan view

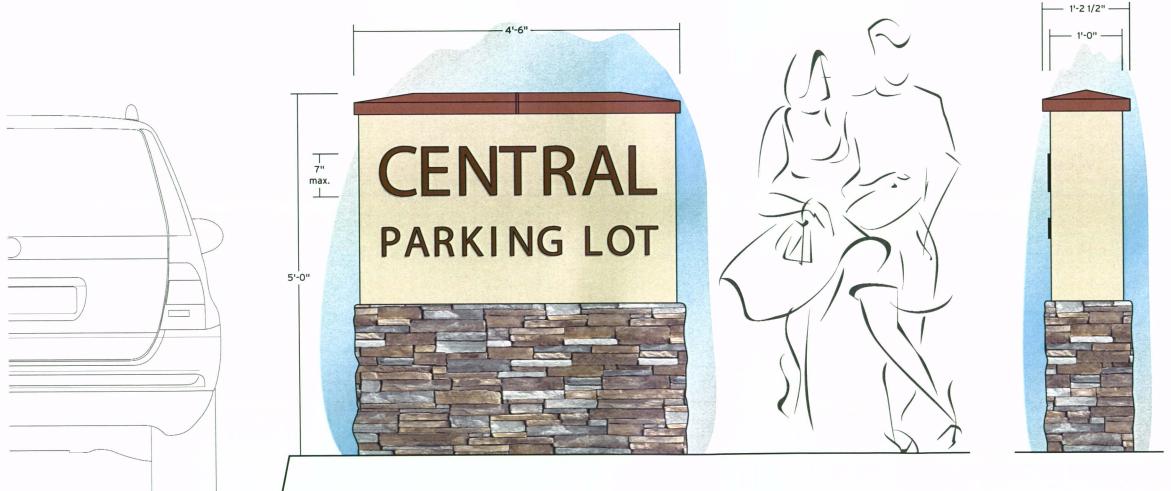

front elevation

side elevation

Elevations and Plan View

Scale: 3/4" = 1'-0"



Campus Site: Planned Sign Program

Signtype: V5 Parking Lot Entry Identification Sign Conceptual Design

V5 Parking Lot Entry Identification Sign

Colors

Сору

Note

Wall Cap

Stucco Wall

Stone Veneer

Concrete block monument wall with project standard painted stucco, rock veneer and colored pre-cast concrete wall cap. Copy to be 1/2" thick flat cut out painted aluminum; stud mounted with 1/8" deep spacers painted to match

Frazee Ocrah Rust; FZ8245A

Frazee Brick Shadow; FZ8326N

Project Standard Color

Project Standard Stone


Figures show typical example of verbage. Exact verbage will

SB - V5.0 Date 12-08-05

Saddleback Church



plan view

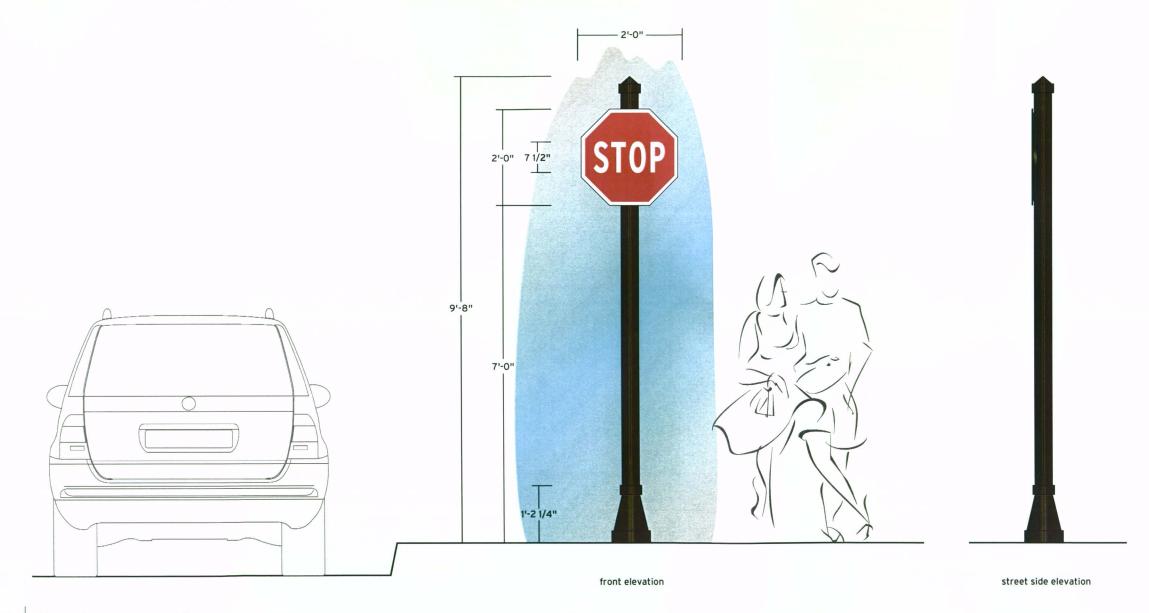

Elevations and Plan View

Scale: 1/2" = 1'-0"



Saddleback Church Campus Site: Planned Sign Program Signtype: V6 Vehicular Regulatory Sign Conceptual Design

SB - V6.0 Date 12-08-05

V6 Stop Sign

Flat cut out octagonal painted 1/4" thick aluminum face panel with applied die cut vinyl and protective satin clear coat; secured to sub-panel with VHB tape and silicon. Subpanel to be 1" undersized flat cut out octagonal painted 1/8" thick aluminum; mechanically secured to mounting bracket. Bracket to be 1" x 2", 1/8" wall aluminum "U" channel welded to support post. Support post to be 3" square, 3/16" wall, painted aluminum tube. Post to have mechanically secured, painted cast aluminum cap and base cladding.


Colors


Benjamin Moore Deep Bronze Post, Cap and Base Sign Face/Sub-panel Frazee Alert Red

Copy and Border White Reflective Vinyl

Note

This figure describes typical mounting and pole for all regulatory signs. Exact signage and location will be project specific and included with each specific building department submittal.

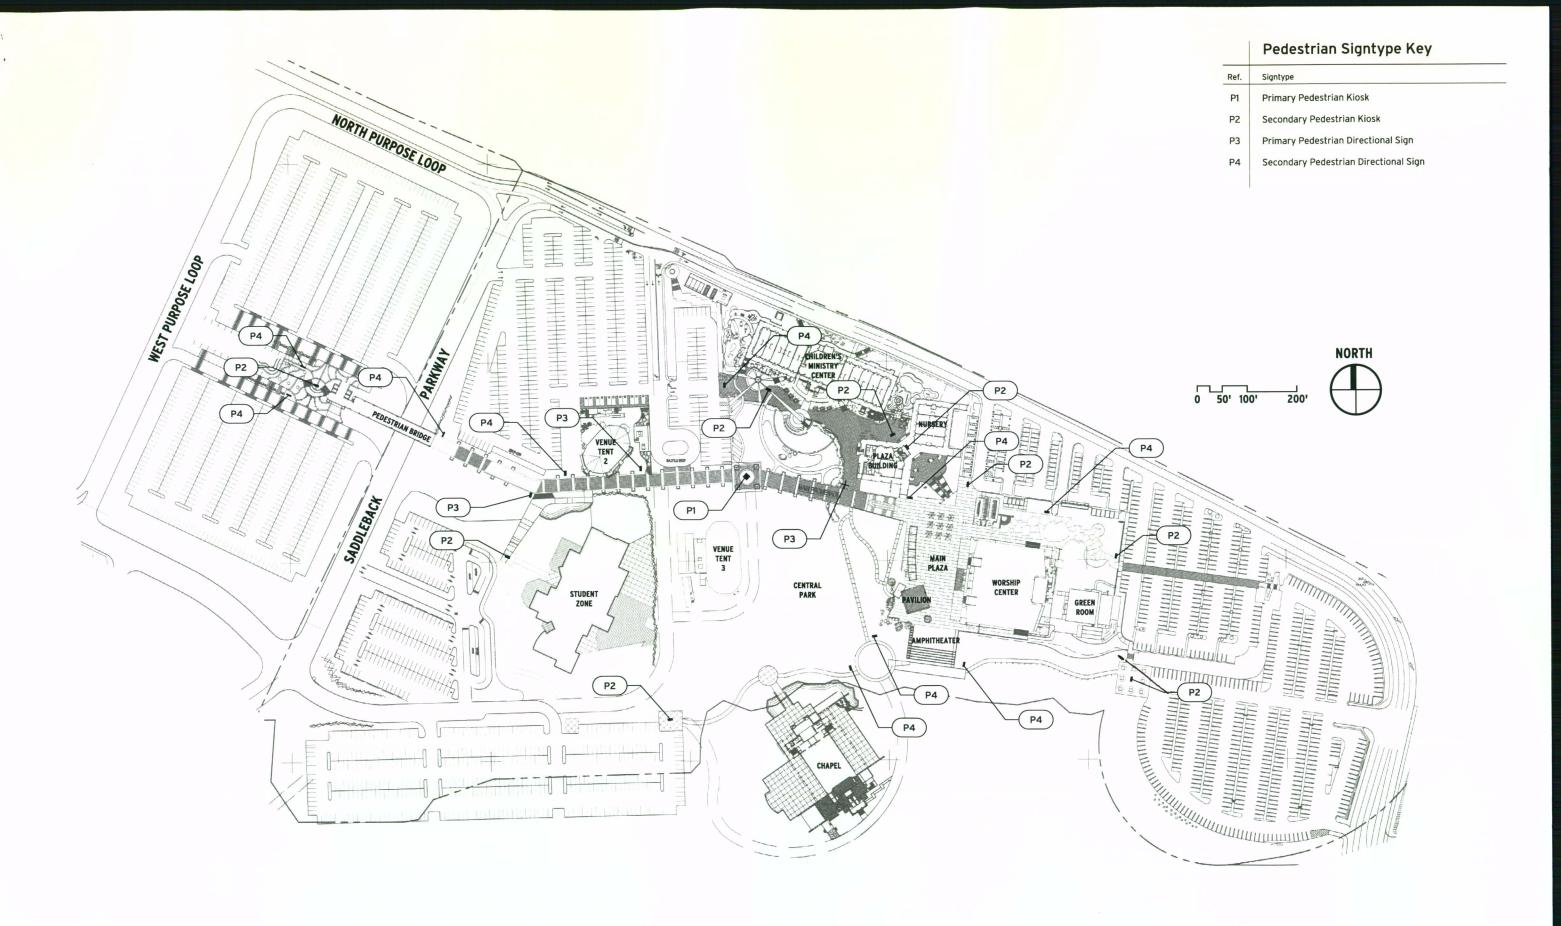

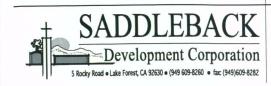


Project

Saddleback Church


Campus Site: Planned Sign Program

Pedestrian Wayfinding Sign Location Plan SB - PSP

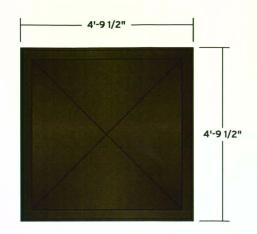

2 Plan View

Scale: 3/8" = 1'-0"

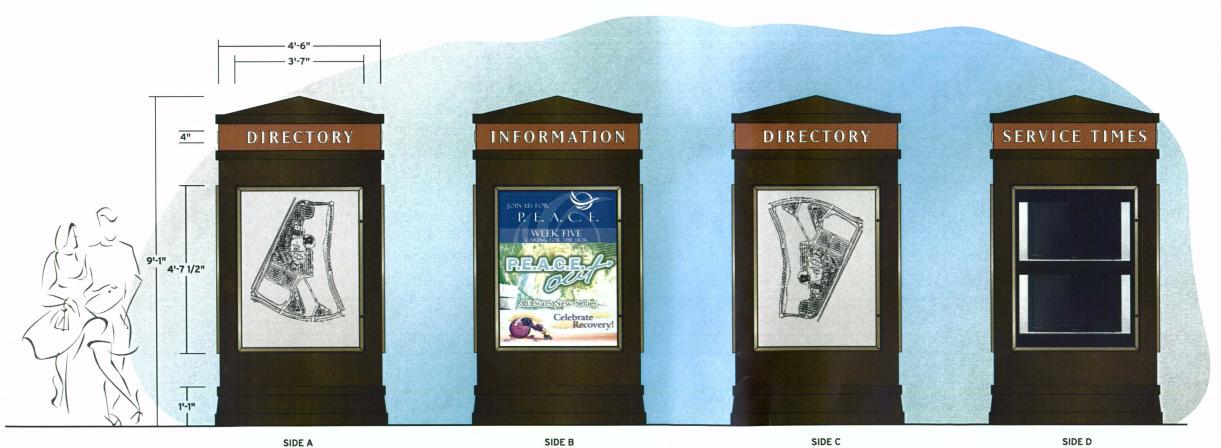

static backlit digitally printed directory map SIDE B static backlit digitally printed poster SIDE C static backlit digitally printed directory map SIDE D remote modified schedule/message center

1 Elevations

Scale: 3/8" = 1'-0"



Project

Saddleback Church

Campus Site: Planned Sign Program

Sheet Title
Signtype: P1
Primary Pedestrian Kiosk
Conceptual Design

Primary Pedestrian Kiosk

Colors

Note

Display Cabinets

Header Panel Copy

Header Panel

very per sign.

Four sided fabricated painted aluminum kiosk with internally illuminated push-thru acrylic header panel copy and semi flush mounted display cabinets. Each of the four display cabinets to be weatherproof with internal venting and cooling fans. Three of the four display cabinets to be backlit and to allow for

digitally printed translucent poster/directory inserts. The remaining cabinet to have a remote operated changeable schedule/message center (final fixture to be determined).

Cabinet, Cap and Base Benjamin Moore Deep Bronze

Figures show typical example of verbage. Exact verbage will


Matthews Warm Metallic; MP20046

Frazee Ocrah Rust; FZ8245A

Translucent White Acrylic


SB - P1.0

Date
12-08-05

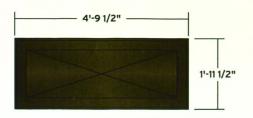

3 Plan View


Scale: 3/8" = 1'-0"

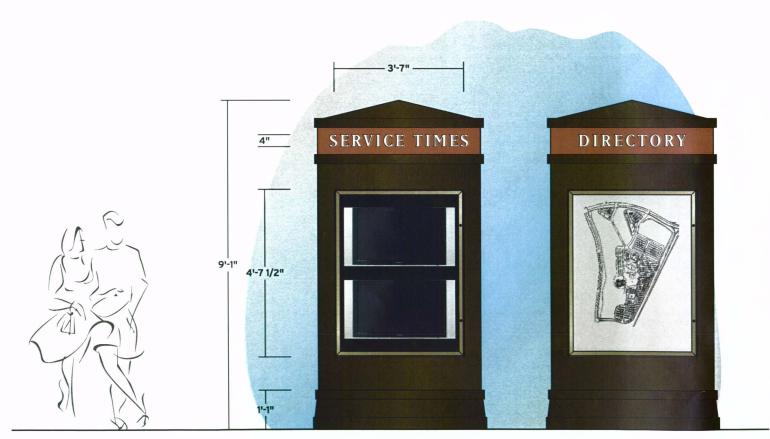

SIDE A remote modified schedule/message center SIDE B static backlit digitally printed directory map

1 Face Elevations

Scale: 3/8" = 1'-0"

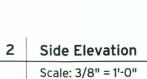

P2 Secondary Pedestrian Kiosk

Two sided fabricated painted aluminum kiosk with internally illuminated push-thru acrylic header panel copy and semi flush mounted display cabinets. Each of the four display cabinets to be weatherproof with internal venting and cooling fans. One sides display cabinet to be backlit to allow for a digitally printed directory map insert. The other sides dispay cabinet to have a remote operated changeable schedule/message center (final fixture to be determined). Each end to have removable access panels with weather resistant clear acrylic brochure holders.

Colors


Cabinet, Cap and Base Benjamin Moore Deep Bronze

Display Cabinets Matthews Warm Metallic; MP20046

Header Panel Frazee Ocrah Rust; FZ8245A
Header Panel Copy Translucent White Acrylic

Vote

Figures show typical example of verbage. Exact verbage will very per sign.

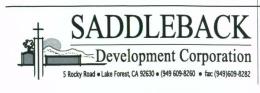



Project
Saddleback Church
Campus Site: Planned Sign Program

Sheet Title
Signtype: P2
Secondary Pedestrian Kiosk
Conceptual Design

SB - P2.0

Date
12-08-05

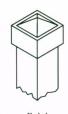


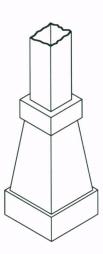

base cladding

3 Isometric View - Base and Finial

Scale: 1" = 1'-0"

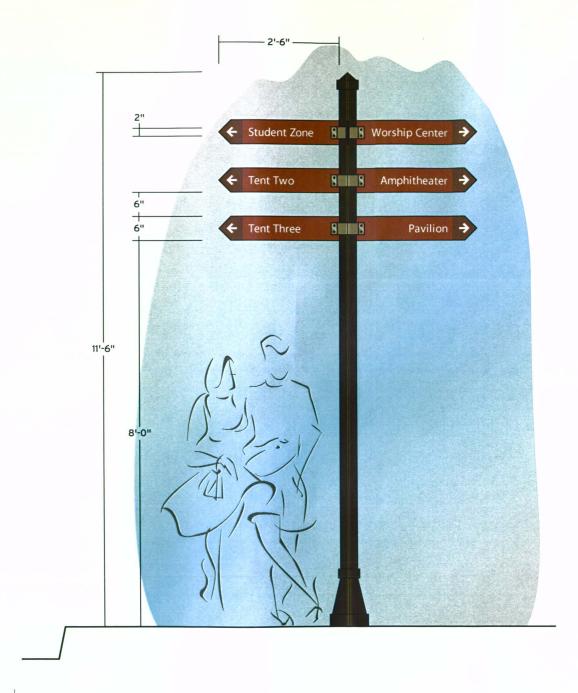

1 Elevation

Scale: 1/2" = 1'-0"

P3 Primary Pedestrian Directional Sign

Post and multi-panel sign with 1/4" thick painted aluminum sign panels mechanically secured to support post with custom cut painted aluminum bracketing system. Copy to be applied die cut vinyl with protective satin clear coat.

Support post to be 3" square, 3/16" wall, painted aluminum tube, with 45° rotation, painted cast aluminum base cladding and finial.

Colors

Post, Cap and Base Benjamin Moore Deep Bronze

Brackets Matthews Warm Metallic; MP20046


Sign Panels Frazee Ocrah Rust; FZ8245A

Sign Panel Accent Frazee Brick Shadow; FZ8326N

Copy White Reflective Vinyl


Note

Figures show typical example of verbage. Exact verbage will very per sign.

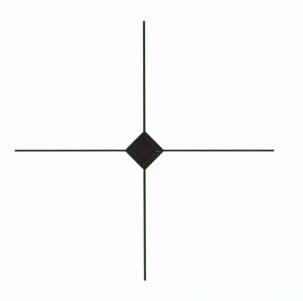

Plan View

Scale: 1/2" = 1'-0"

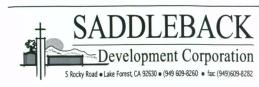


Saddleback Church
Campus Site: Planned Sign Program

Sheet Title
Signtype: P3
Primary Pedestrian Directional Sign
Conceptual Design

SB - P3.0

12-08-05



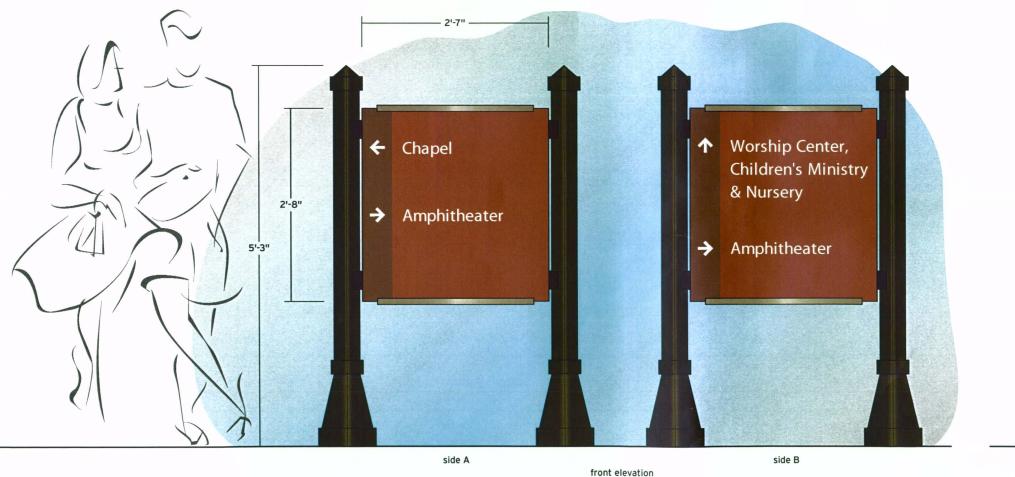



Plan View and Elevations

Scale: 3/4" = 1'-0"



Project

Saddleback Church

Campus Site: Planned Sign Program

Sheet Title
Signtype: P4
Secondary Pedestrian Directional Sign
Conceptual Design

P4 Secondary Pedestrian Directional Sign

Two sided post and panel sign. Face panels to be 1/4" thick painted aluminum with applied die cut vinyl with protective satin clear coat; mechanically secured to support posts with custom fabricated painted aluminum bracketing system.

Fabricated painted aluminum accent bars to be mechanically secured to top/bottom of face panels. Support posts to be 3"

square, 3/16" wall, painted aluminum tube. Each post to have mechanically secured, painted cast aluminum cap and base

Face Panel Side Strip Frazee Brick Shadow; FZ8326N

Figures show typical example of verbage. Exact verbage will

Benjamin Moore Deep Bronze

Frazee Ocrah Rust; FZ8245A

White Reflective Vinyl

Matthews Warm Metallic; MP20046

cladding.

Colors

Post, Cap and Base

Accent Bars

Face Panels


Сору

Note

very per sign.

SB - P4.0

Date
12-08-05

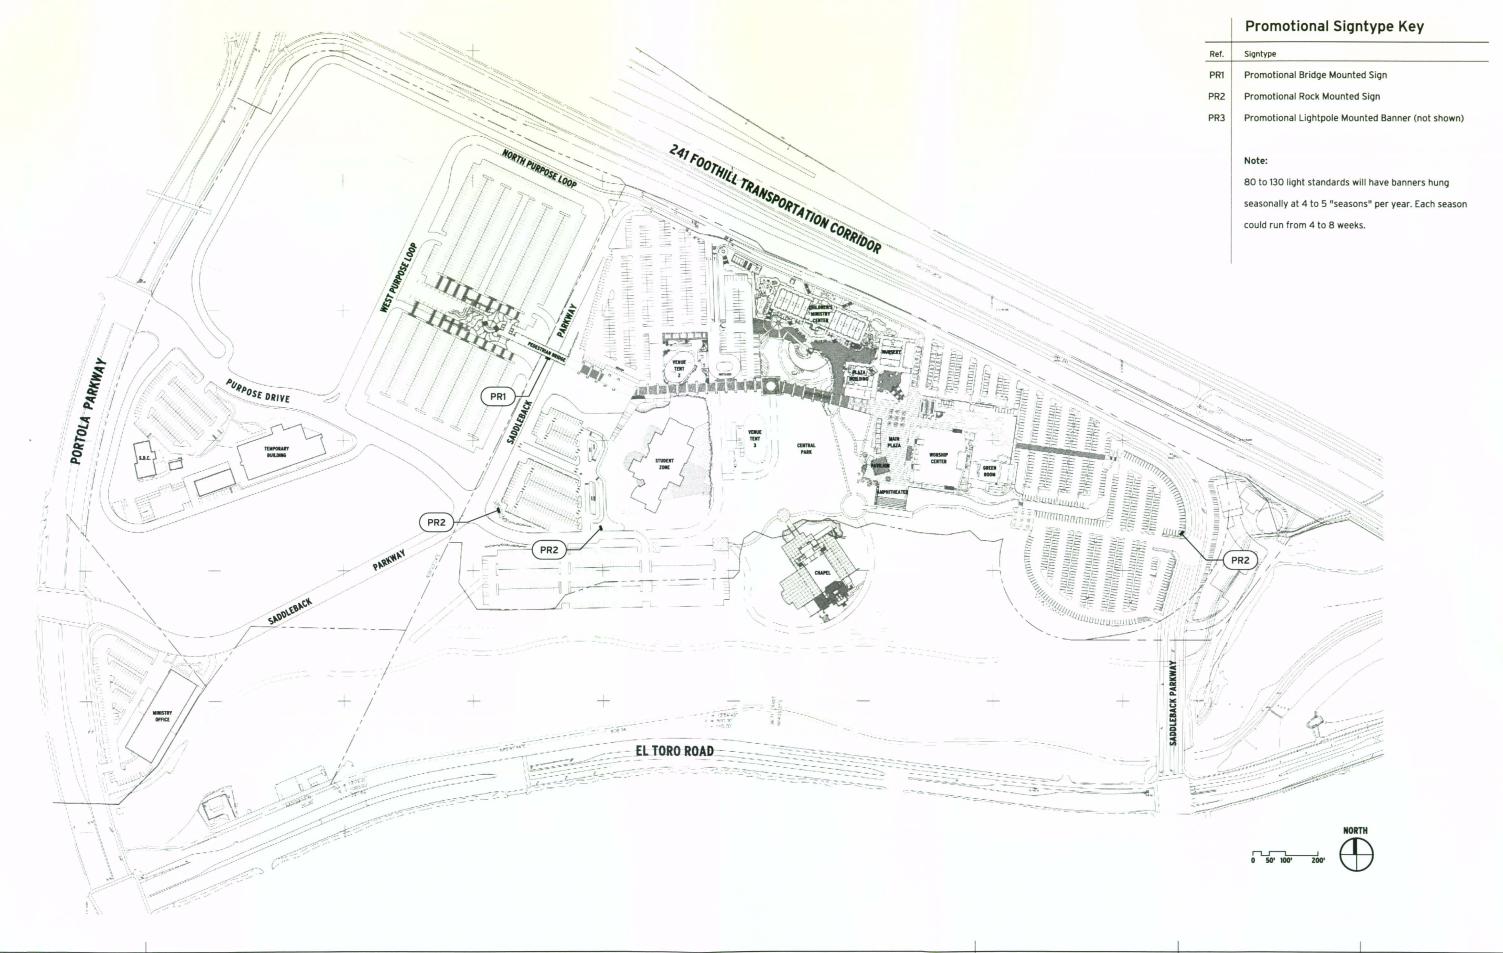



Project

Saddleback Church


Campus Site: Planned Sign Program

Promotional Signs
Site Location Plan

Sheet Number
SB - PRSP
Date
12-08-05

PR1 Promotional Bridge Mounted Sign

Changeable banner mechanically secured to face of bridge structure. Maximum size to be no more than 4' tall by 40' long.

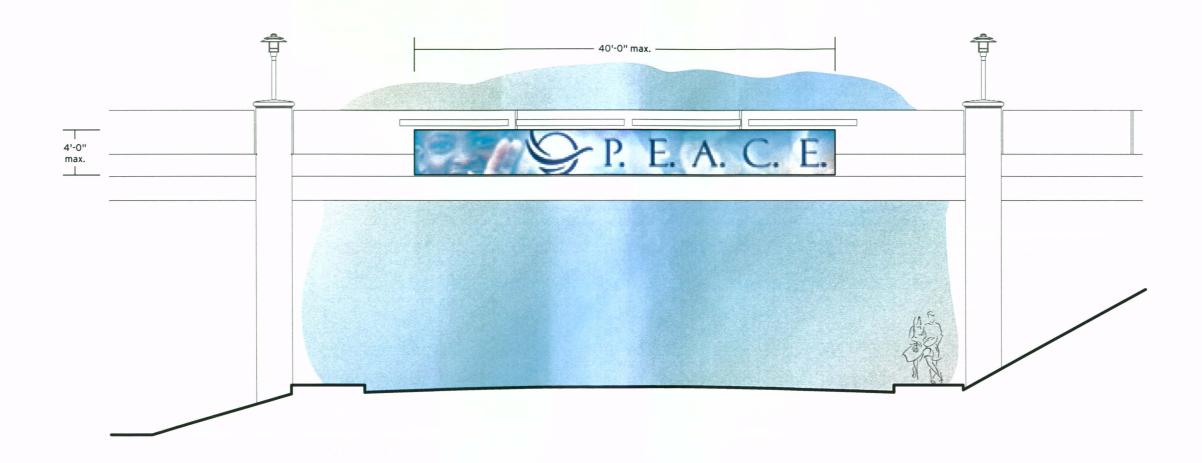

1 Elevation

Scale: 1/8" = 1'-0"



Project
Saddleback Church
Campus Site: Planned Sign Program

Sheet Title
Signtype: PR1
Promotional Bridge Mounted Sign
Conceptual Design

SB - PR1.0

Date
12-08-05





1 PR2 - Photo of Existing Promotional Signage (typical dimensions 5' x 12')

Scale: n.t.s.

PR3 - Photo of Existing Promotional Signage (typical dimensions 60" x 30")

Scale: n.t.s.



Project

Saddleback Church

Campus Site: Planned Sign Program


Sheet Title
Signtype: PR2, PR3
Photos of Existing Promotional
Signage

SB - PR1.1

B1 Existing Building Identification

Note

Typical building identification sign font, color and material to be located and described with each individual building plan check submittal.

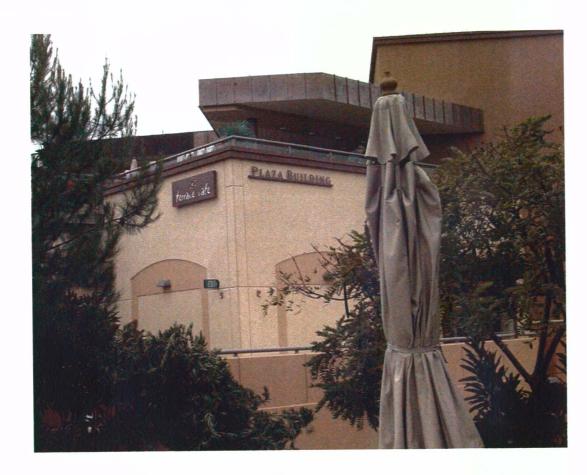



1 Exisiting Location Photo (Plaza Building)

Scale: n.t.s.

2 Exisiting Location Photo (Pavilion)

Scale: n.t.s.

Saddleback Church
Campus Site: Planned Sign Program


Sheet Title
Signtype: B1
Photos of Existing Building
Indentification

Sheet Number
SB - B1.1

B1 Existing Building Identification

Note:

Typical building identification sign font, color and material to be located and described with each individual building plan check submittal.

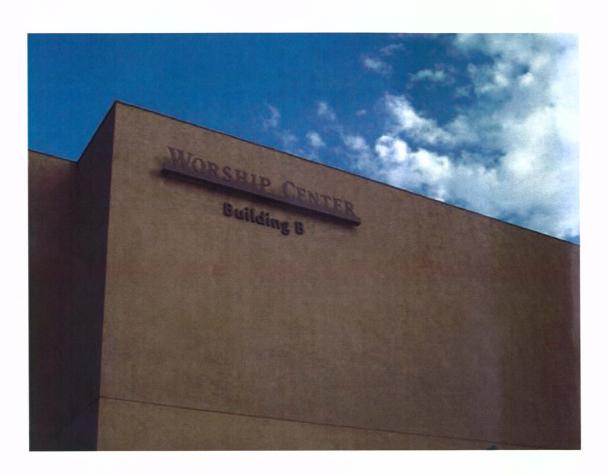



1 Exisiting Location Photo (Worship Center)

Scale: n.t.s.

2 Exisiting Location Photo (Nursery Building)

Scale: n.t.s.

Project

Saddleback Church

Campus Site: Planned Sign Program

Sheet Title
Signtype: B1
Photos of Existing Building
Indentification

Sheet Number
SB - B1.0

Date
12-08-05